




01 NEW GATELINE PAVILION - REFLECTED CEILING PLAN
1:100

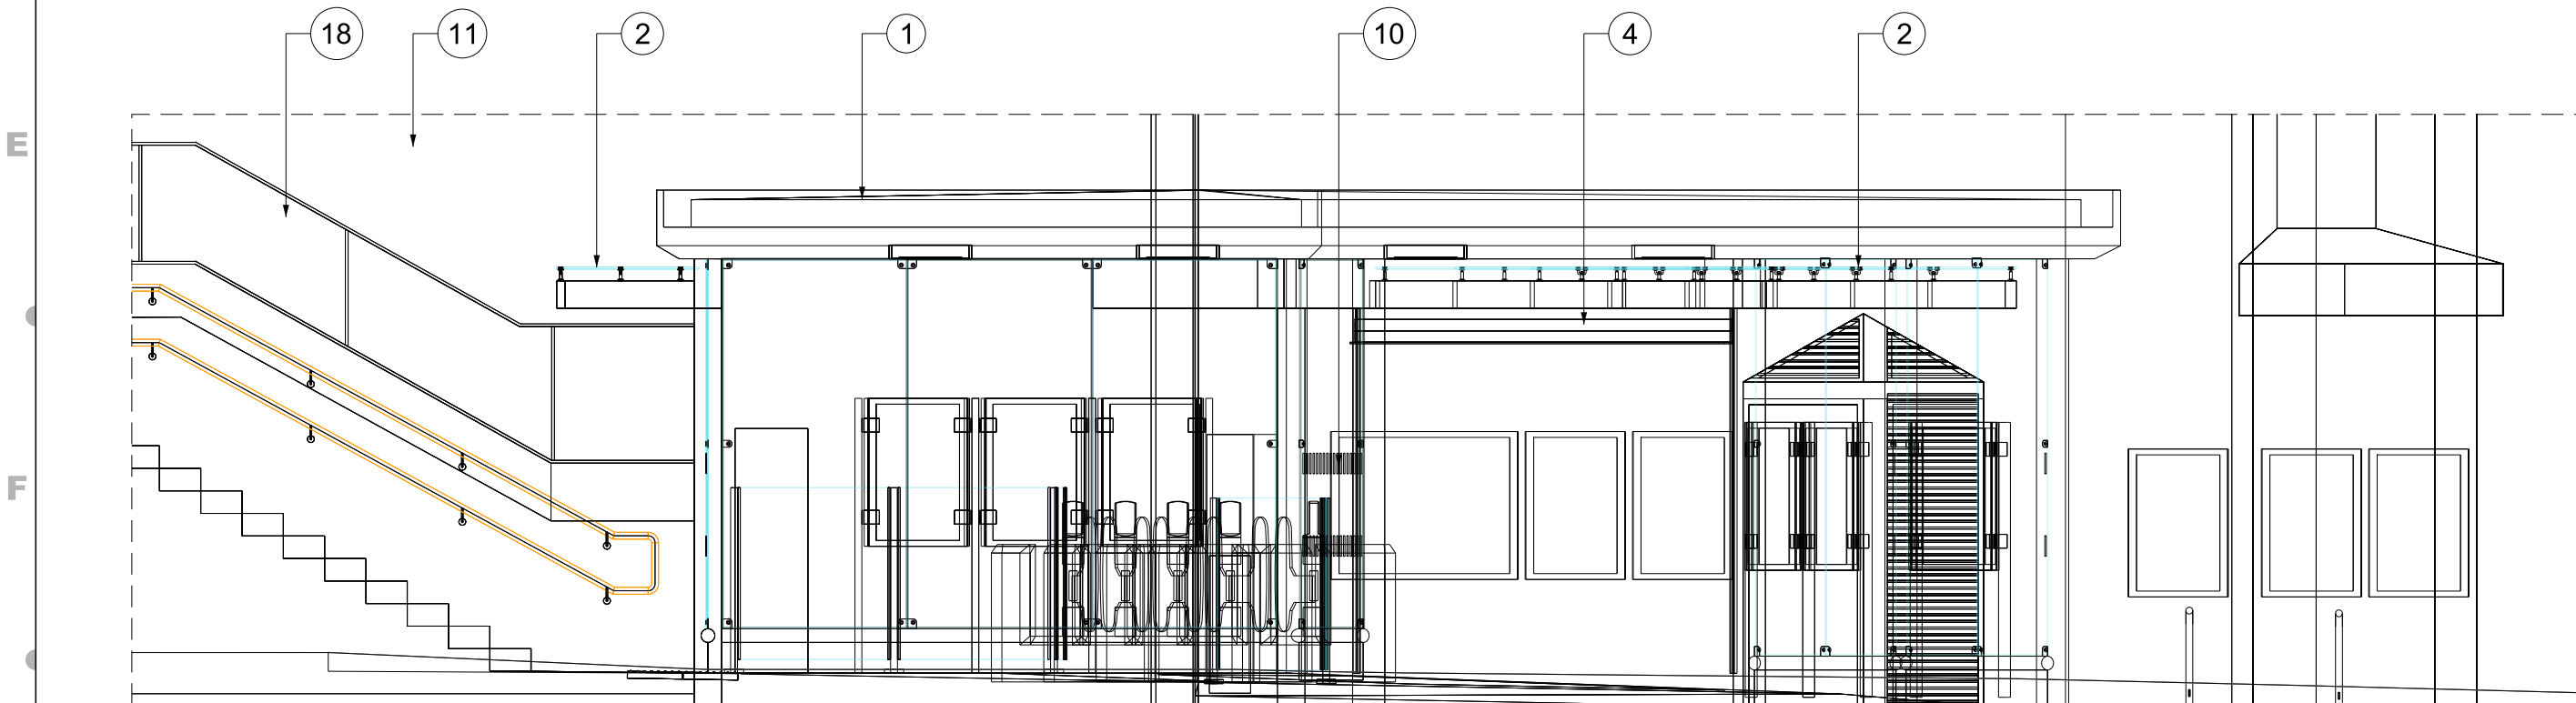


04 NEW GATELINE PAVILION - ELEVATION A
1:50

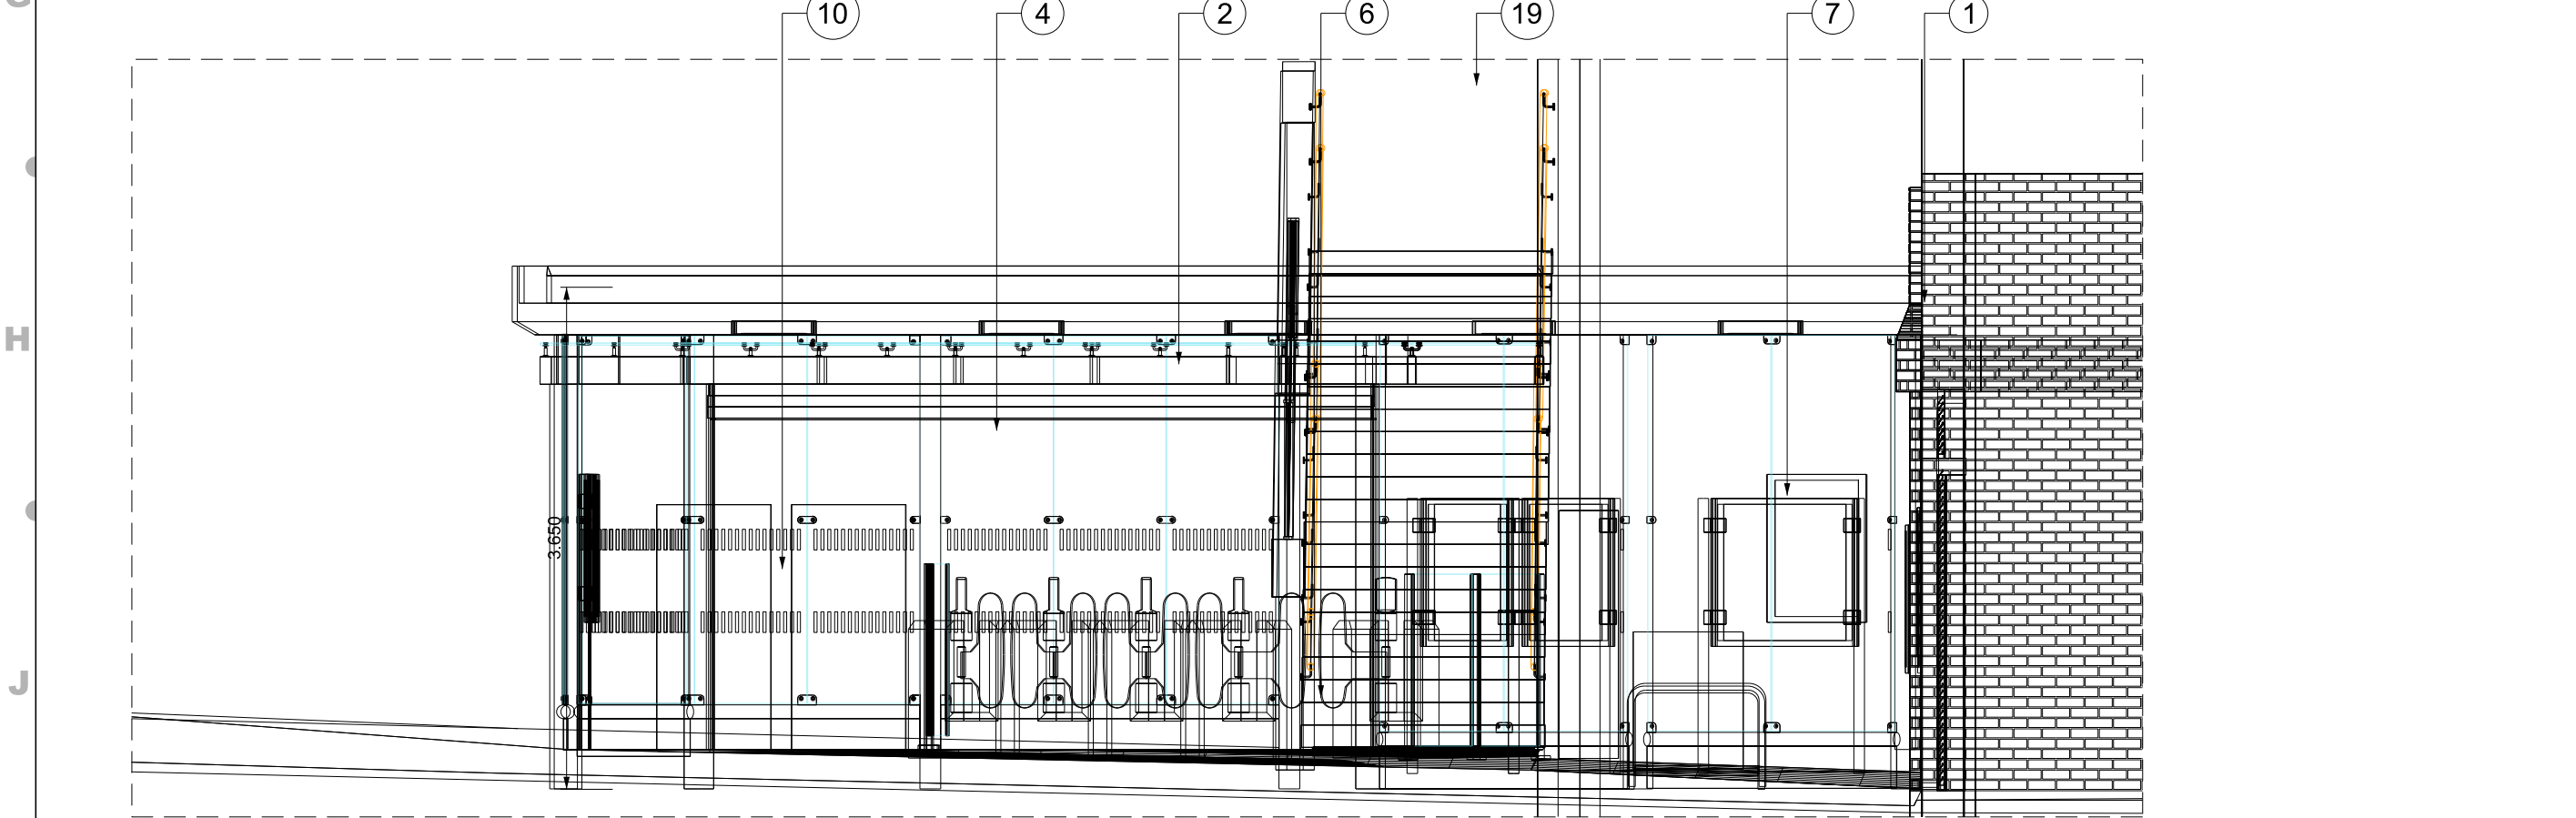


04 NEW GATELINE PAVILION - ELEVATION B
1:50

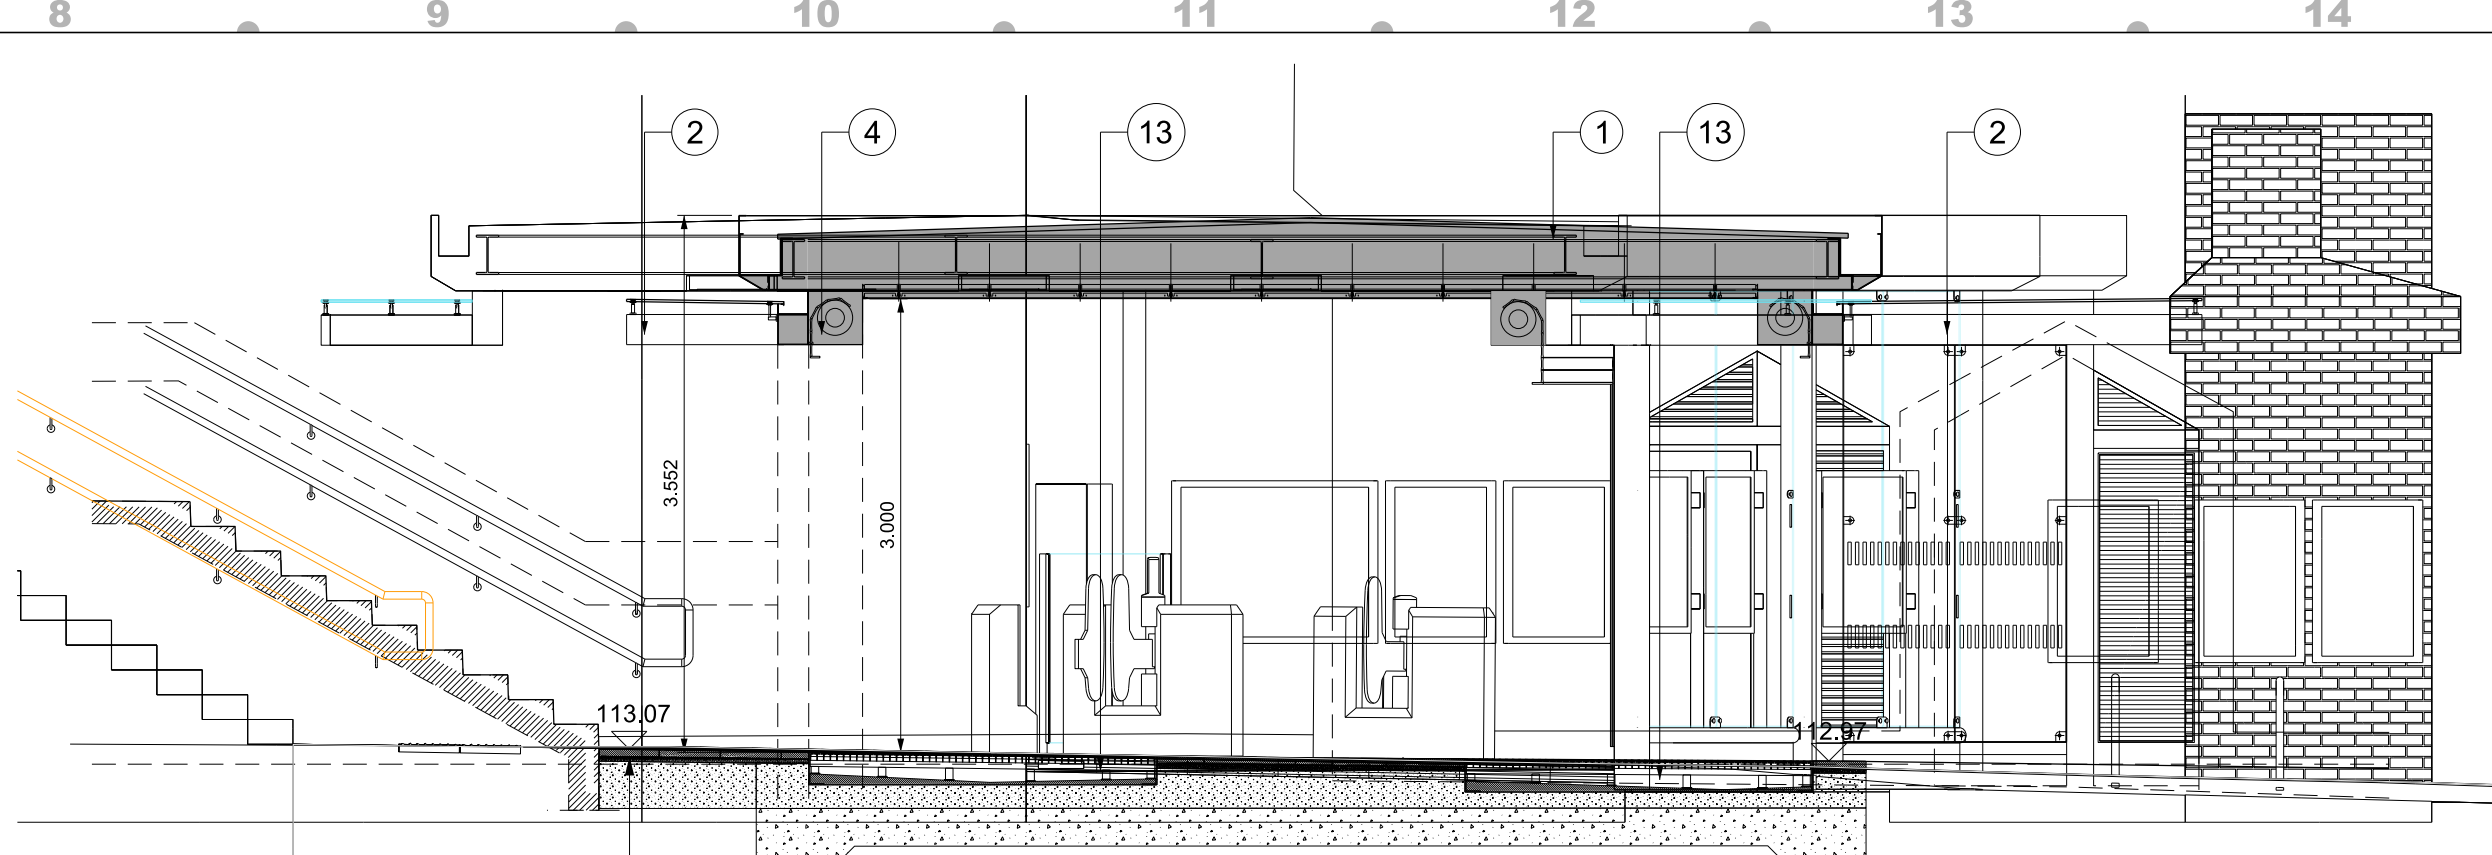

02 NEW GATELINE PAVILION - SECTION A-A
1:50

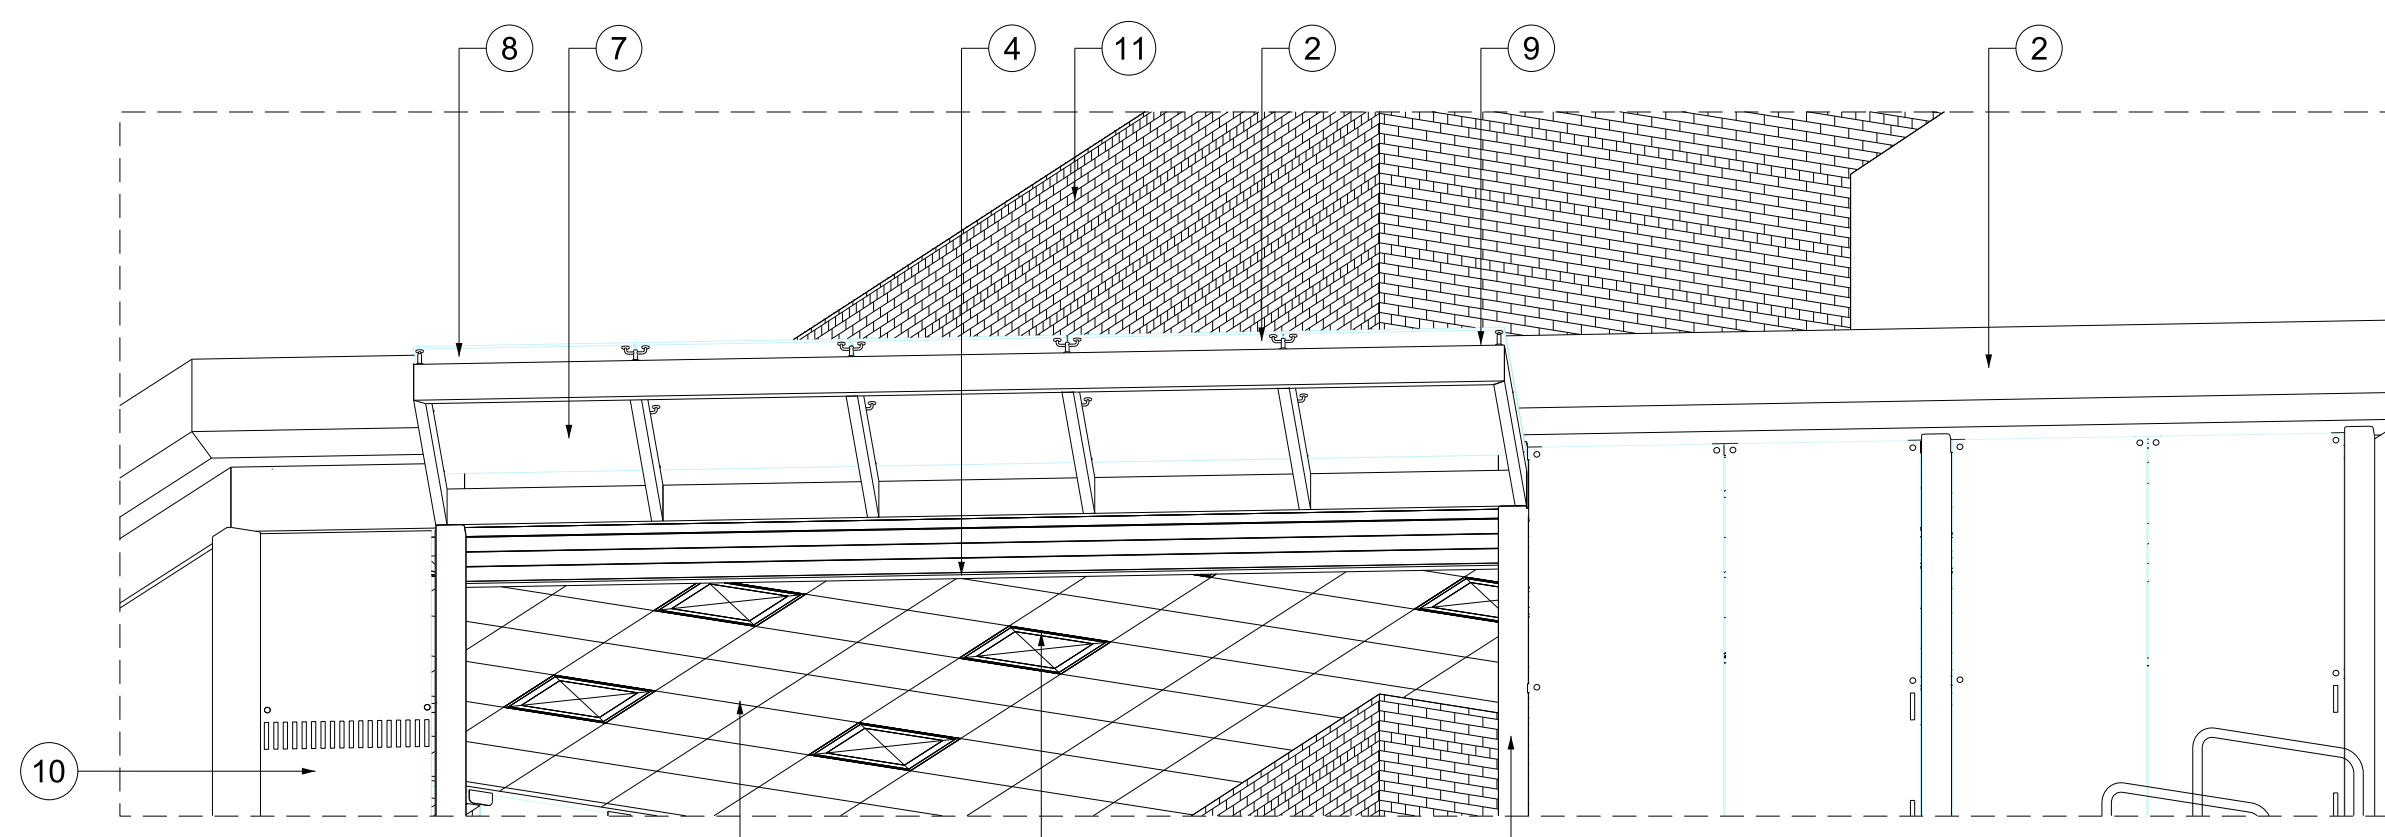

05 NEW GATELINE PAVILION - ISOMETRIC DETAIL
NA

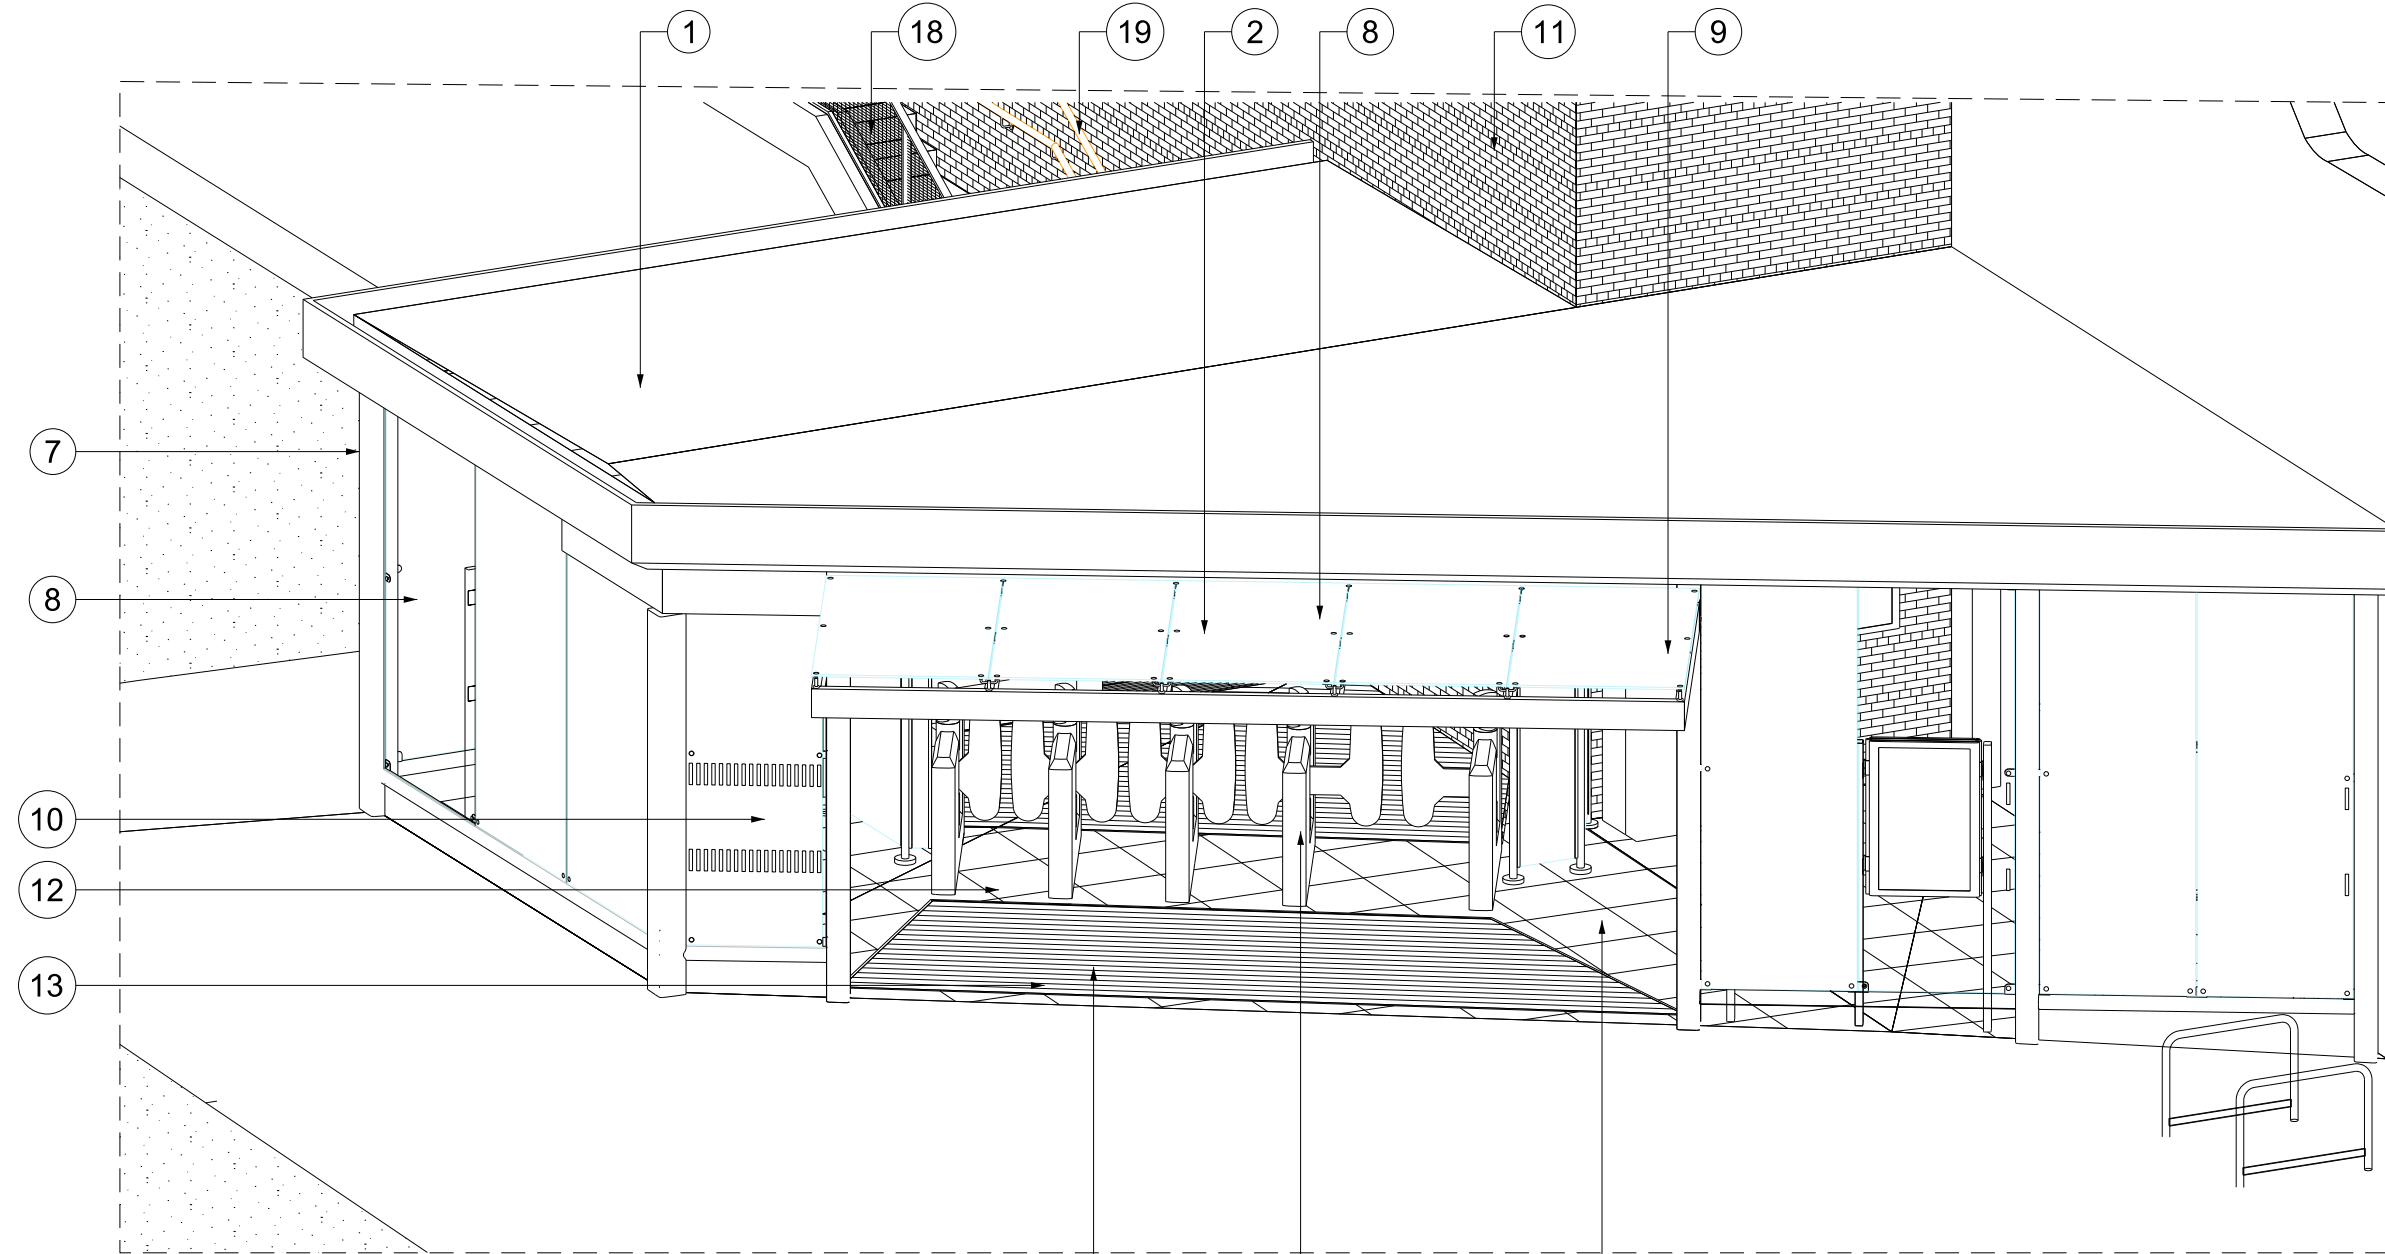

06 NEW GATELINE PAVILION - ISOMETRIC
NA

NOTES - LEGEND:

ALL DIMENSIONS IN MILLIMETRES UNLESS OTHERWISE STATED.

ALL LEVELS ARE IN METRES ABOVE ORDNANCE DATUM UNLESS OTHERWISE NOTED.

THIS DRAWING IS BASED ON TPS SURVEY AND DRAWING INFORMATION ISSUED BY LONDON OVERGROUND.



THIS DRAWING TO BE READ IN CONJUNCTION WITH ALL OTHER ARCHITECTS DRAWINGS AS LISTED IN THE DRAWING SCHEDULE BELOW.

ALL DRAWINGS TO BE READ IN CONJUNCTION WITH ALL OTHER RELEVANT ENGINEER'S DRAWINGS AS LISTED IN THE DRAWING SCHEDULE.

FOR LOADINGS, FIXING DETAILS REFER TO STRUCTURAL ENGINEERS DRAWINGS AS LISTED IN THE DRAWING SCHEDULE BELOW AND SPECIFICATIONS ALSO.

 LIVE 25KV OHLE PRESENT AT STATION

KEY PLAN

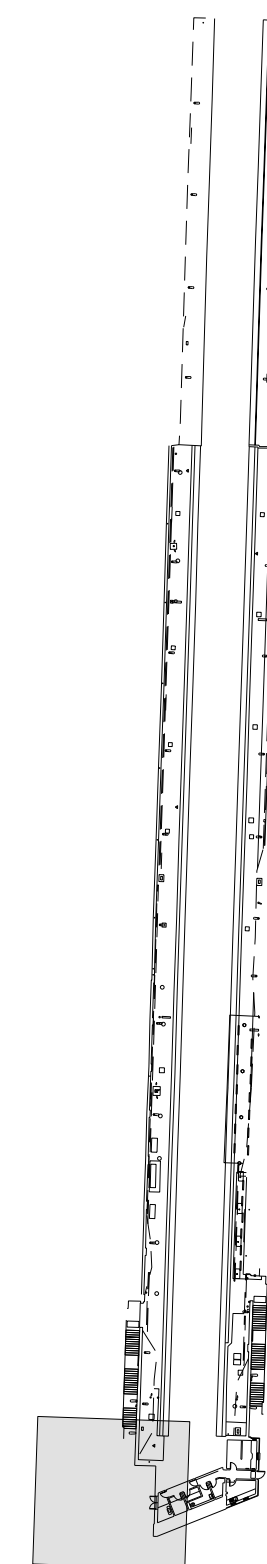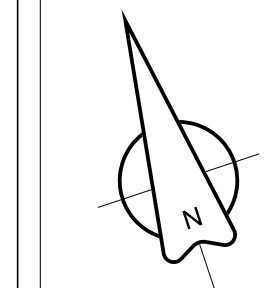

NOTES - LEGEND:

- | | | | |
|---|---|---|--|
| 1 NEW GATELINE PAVILION | 8 NEW GATELINE 3 + 1 TO BE INSTALLED BY CUBIC. | 12 NEW FLOOR THROUGHOUT NEW PAVILION TO BE 'PROSPERO' GRANITE PAVING SLABS BY MARSHALLS. SLABS TO BE 600x600x50mm FLAMED FINISH. REFER TO NBS SPEC CLAUSE M40 115 | 17 NEW FREE- STANDING HINGED INTEGRATED POSTER FRAME UNIT EIGHT DOUBLE ROYAL POSTER FRAMES SEE DRAWING WASP-ALLW-EAR-DDE-PEL-00008 |
| 2 NEW GLASS AND STAINLESS STEEL CANOPY. | 7 STAINLESS STEEL CANOPY SUPPORTS | 13 NEW DRAINED MATWELL BY ENTRANCE MATTING SOLUTIONS. REFER TO NBS CLAUSE N10 301 FOR DETAILS | 18 NEW FENCE TO TOP OF SECOND LANDINGS |
| 3 NEW LIGHTING UNIT INTEGRATED WITHIN CEILING. LOCATION SHOWN FOR INDICATIVE PURPOSES ONLY. LIGHTING UNIT TO M&E ENGINEERS SPECIFICATION. ALL LIGHTING TO BE INCLUDED IN MACEMAIN INSTALLATION. | 8 LAMINATED GLASS | 14 EXISTING BRICK / BLOCK PARAPET WALL TO BE INCREASED | 19 NEW DOUBLE HANDRAIL IN ACCENT COLOUR MS. RAL 2003 SEE DRAWING WASP-ALLW-EAR-DDE-PEL-00002 |
| 4 NEW ROLLER SHUTTER, ACCESSIBLE CASE TO BE FINISHED TO MATCH METAL CEILING. ROLLER SHUTTER TO BE POWDER COATED, COLOUR REF M1 | 9 GLASS TO BE PLANAR FIXED | 15 NEW DOUBLE ROYAL POSTER FRAME. REFER TO NBS CLAUSE M60/190 FOR FURTHER DETAIL. | |
| 5 METAL CEILING PART OF MACEMAIN INSTALLATION. | 10 TOUGHENED GLASS INFILL PANEL WITH REQUIRED MANIFESTATION TO SATISFY PART K REQUIREMENTS. | 16 NEW QUAD ROYAL POSTER FRAME. REFER TO NBS CLAUSE M60/190 FOR FURTHER DETAIL. | |
| | 11 EXISTING RENDER WALL TO BE REPAINTED | | |

CIVIL DRAWING SCHEDULE

WASP-ALLW-ECV-DDE-PEL-00001	ALL STATIONS, STANDARD POST & BENCH
WASP-ALLW-ECV-DDE-PEL-00002	ALL STATIONS, STATION IMPROVEMENTS, GENERIC DETAILS
WASP-ALLW-ECV-DDE-PEL-00003	ALL STATIONS, STATION IMPROVEMENTS, GENERIC DETAILS
WASP-ALLW-ECV-DDE-PEL-00004	ALL STATIONS, STATION IMPROVEMENTS, CONSTRUCTION NOTES
WASP-ALLW-ECV-DDE-PEL-00005	ALL STATIONS, STATION IMPROVEMENTS, GENERIC DETAILS
WASP-LSLV-EAR-DGA-PEL-00001	GA EXISTING STATION PLATFORM 1 OF 3
WASP-LSLV-EAR-DGA-PEL-00002	GA EXISTING STATION PLATFORM 2 OF 3
WASP-LSLV-EAR-DGA-PEL-00003	GA EXISTING STATION PLATFORM 3 OF 3
WASP-LSLV-EAR-DGA-PEL-00004	GA EXISTING STATION PLATFORM 1 OF 3
WASP-LSLV-EAR-DGA-PEL-00005	GA EXISTING STATION PLATFORM 2 OF 3
WASP-LSLV-EAR-DGA-PEL-00006	GA EXISTING STATION PLATFORM 3 OF 3
WASP-LSLV-EAR-DDE-PEL-00007	DETAIL, PROPOSED STATION PLATFORM 1 OF 3
WASP-LSLV-EAR-DDE-PEL-00008	DETAIL, PROPOSED STATION PLATFORM 2 OF 3
WASP-LSLV-EAR-DDE-PEL-00009	DETAIL, PROPOSED STATION PLATFORM 3 OF 3
WASP-LSLV-EAR-DDE-PEL-00010	DETAIL, PROPOSED STATION PLATFORM 1 OF 3

COMMUNICATIONS DRAWING SCHEDULE

WASP-LSLV-ETL-DPL-PEL-00001	COMMS EXISTING COMMUNICATIONS EQUIPMENT
WASP-LSLV-ETL-DPL-PEL-00002	COMMS PROPOSED COMMUNICATIONS EQUIPMENT
WASP-LSLV-ETL-DPL-PEL-00003	COMMS PROPOSED CCTV BOOKING HALL & STAIRS
WASP-LSLV-ETL-DPL-PEL-00004	COMMS PROPOSED CCTV BOOKING HALL & STAIRS
WASP-LSLV-ETL-DSC-PEL-00005	COMMS CCTV SYSTEM SCHEMATIC
WASP-LSLV-ETL-DSC-PEL-00006	COMMS PA SYSTEM SCHEMATIC
WASP-LSLV-ETL-DSC-PEL-00007	COMMS PHP SYSTEM SCHEMATIC
WASP-LSLV-ETL-DSC-PEL-00008	COMMS CCTV SYSTEM SCHEMATIC
WASP-LSLV-ETL-DPL-PEL-00009	COMMS PROPOSED CCTV BOOKING HALL & STAIRS
WASP-LSLV-ETL-DSC-PEL-00010	COMMS CCTV SYSTEM SCHEMATIC
WASP-LSLV-ETL-DSC-PEL-00011	COMMS PA SYSTEM SCHEMATIC
WASP-LSLV-ETL-DSC-PEL-00012	COMMS PHP SYSTEM SCHEMATIC
WASP-LSLV-ETL-DSC-PEL-00013	COMMS CCTV SYSTEM SCHEMATIC
WASP-LSLV-ETL-DSC-PEL-00014	COMMS PA SYSTEM SCHEMATIC
WASP-LSLV-ETL-DSC-PEL-00015	COMMS PHP SYSTEM SCHEMATIC
WASP-LSLV-ETL-DSC-PEL-00016	COMMS CCTV SYSTEM SCHEMATIC
WASP-LSLV-ETL-DSC-PEL-00017	COMMS PA SYSTEM SCHEMATIC
WASP-LSLV-ETL-DSC-PEL-00018	COMMS PHP SYSTEM SCHEMATIC
WASP-LSLV-ETL-DSC-PEL-00019	COMMS CCTV SYSTEM SCHEMATIC
WASP-LSLV-ETL-DSC-PEL-00020	COMMS PA SYSTEM SCHEMATIC

ELECTRICAL DRAWING SCHEDULE

WASP-LSLV-ELL-DPL-PEL-00001	COMMUNICATION POWER SUPPLIES
WASP-LSLV-ELL-DPL-PEL-00002	COMMUNICATION POWER SUPPLIES
WASP-LSLV-ELL-DPL-PEL-00003	PLATFORM 1 ENTRANCE COMMUNICATION
WASP-LSLV-ELL-DPL-PEL-00004	PLATFORM 2 ENTRANCE COMMUNICATION
WASP-LSLV-ELL-DPL-PEL-00005	PLATFORM 3 ENTRANCE COMMUNICATION
WASP-LSLV-ELL-DPL-PEL-00006	PLATFORM 1 ENTRANCE LIGHTING
WASP-LSLV-ELL-DPL-PEL-00007	PLATFORM 2 ENTRANCE LIGHTING
WASP-LSLV-ELL-DPL-PEL-00008	PLATFORM 3 ENTRANCE LIGHTING
WASP-LSLV-ELL-DDE-PEL-00009	GENERAL ELECTRICAL SCHEMATIC
WASP-LSLV-ELL-DDE-PEL-00010	ARRANGEMENT OF NEW GATELINE EQUIPMENT ENCLOSURE

COORDINATES TO LONDON SURVEY GRID.
PROJECT LEVEL DATUM IS
100 METRES BELOW NEWLYN DATUM.

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DO NOT SCALE
DISTORTION CAN OCCUR

T1L - CAD COMPLIANCE CHECK
XXXX | ##.##.## | #####
PASS OR FAIL

NAME	DATE
DRAMA: M. Szaladewicz	03/11/15
CHK BY: ---	---
APP BY: ---	---
CAD CHECKED BY: Cad Checked Name	##.##.##
APPROVED BY: ---	---

PROJECT

LONDON OVERGROUND West Anglia Stations Programme	
SILVER STREET DETAIL PROPOSED GATELINE P2 PAVILION	
TITLE	SUITABILITY
SHEET X of Y	D2
DRAWING SHEET SIZE = A1	SCALE 1:50
WASP - LSLV - EAR - DDE - PEL - 00011	
DRAWING NUMBER	
T01.1	
REVISION	